



Fuel Storage Tanks, Fuel Polishing & Transfer System Plan Scale 1:250




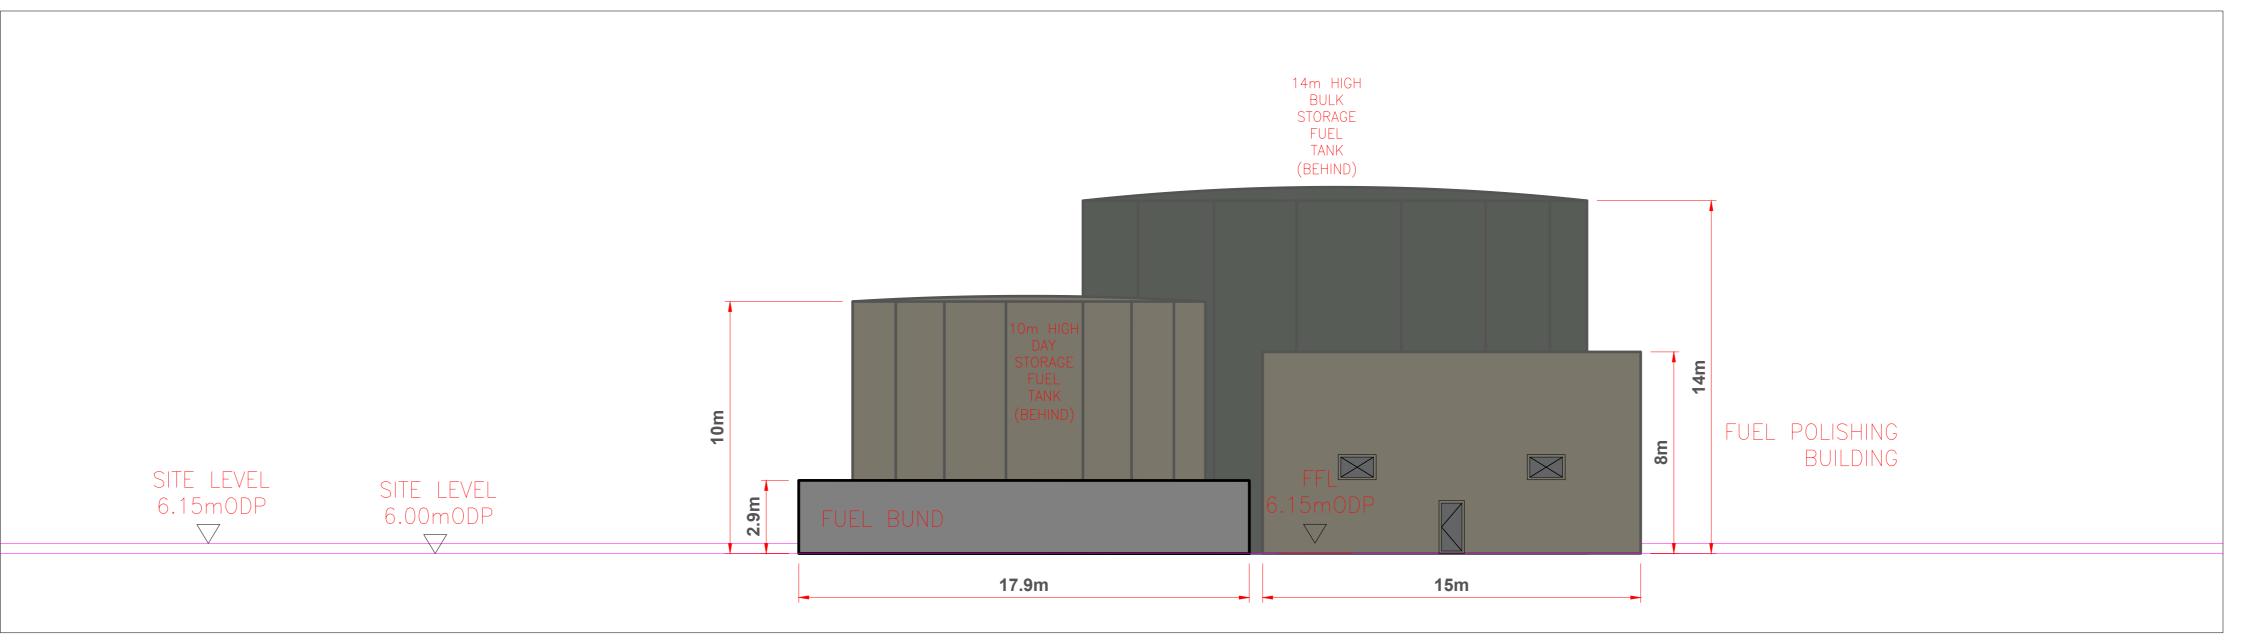


A-A NORTH WEST ELEVATION

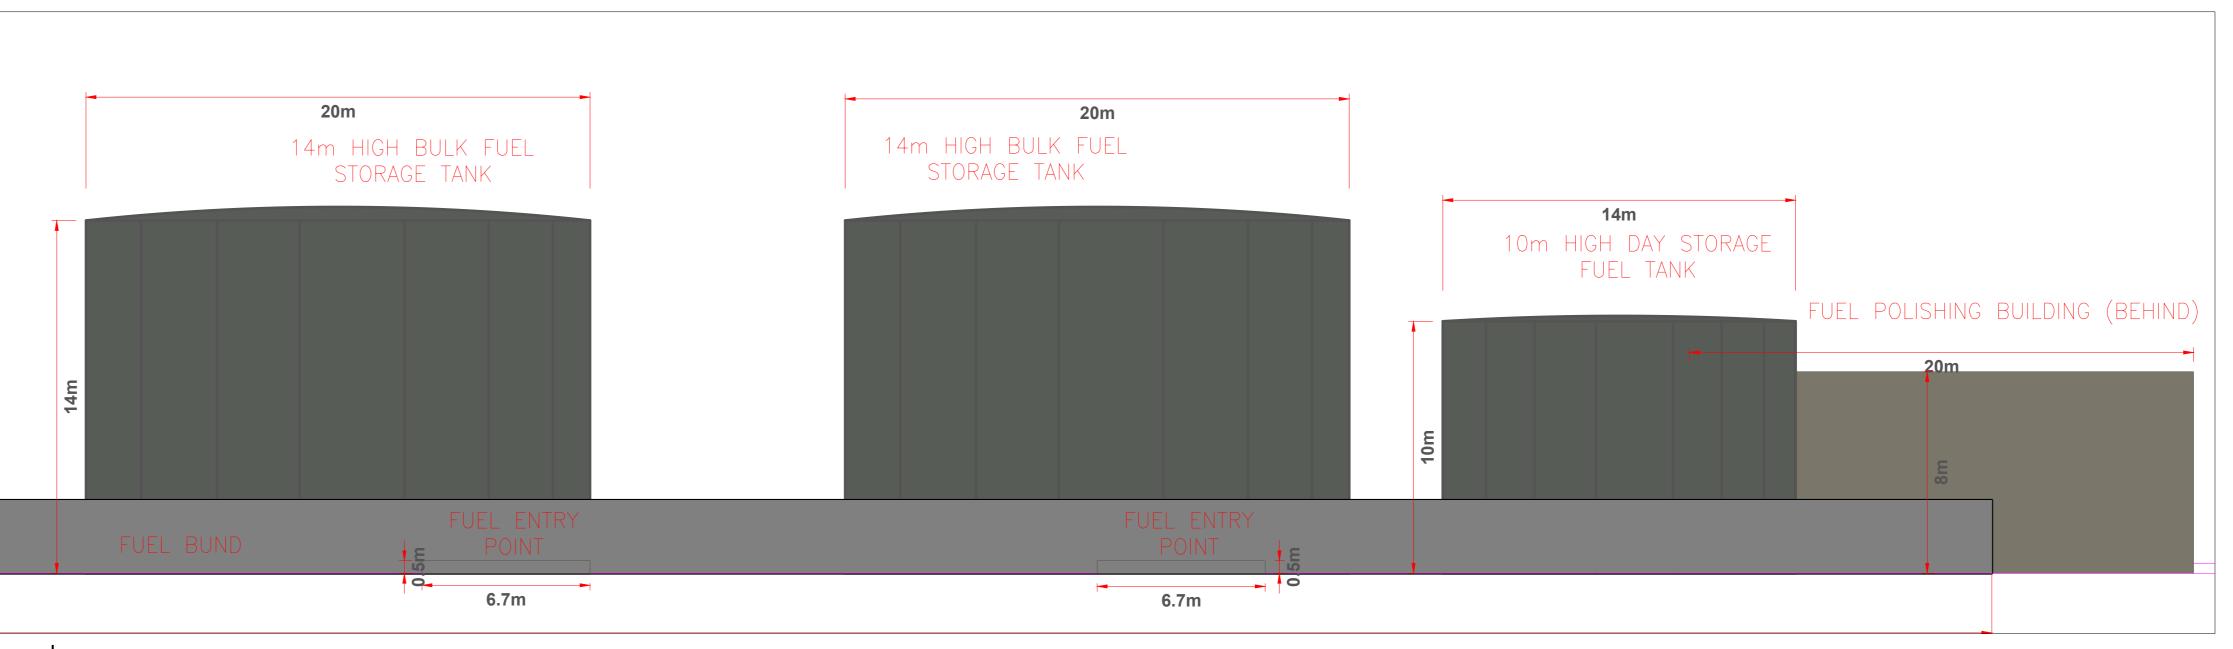

B-B NORTH EAST ELEVATION
1:150

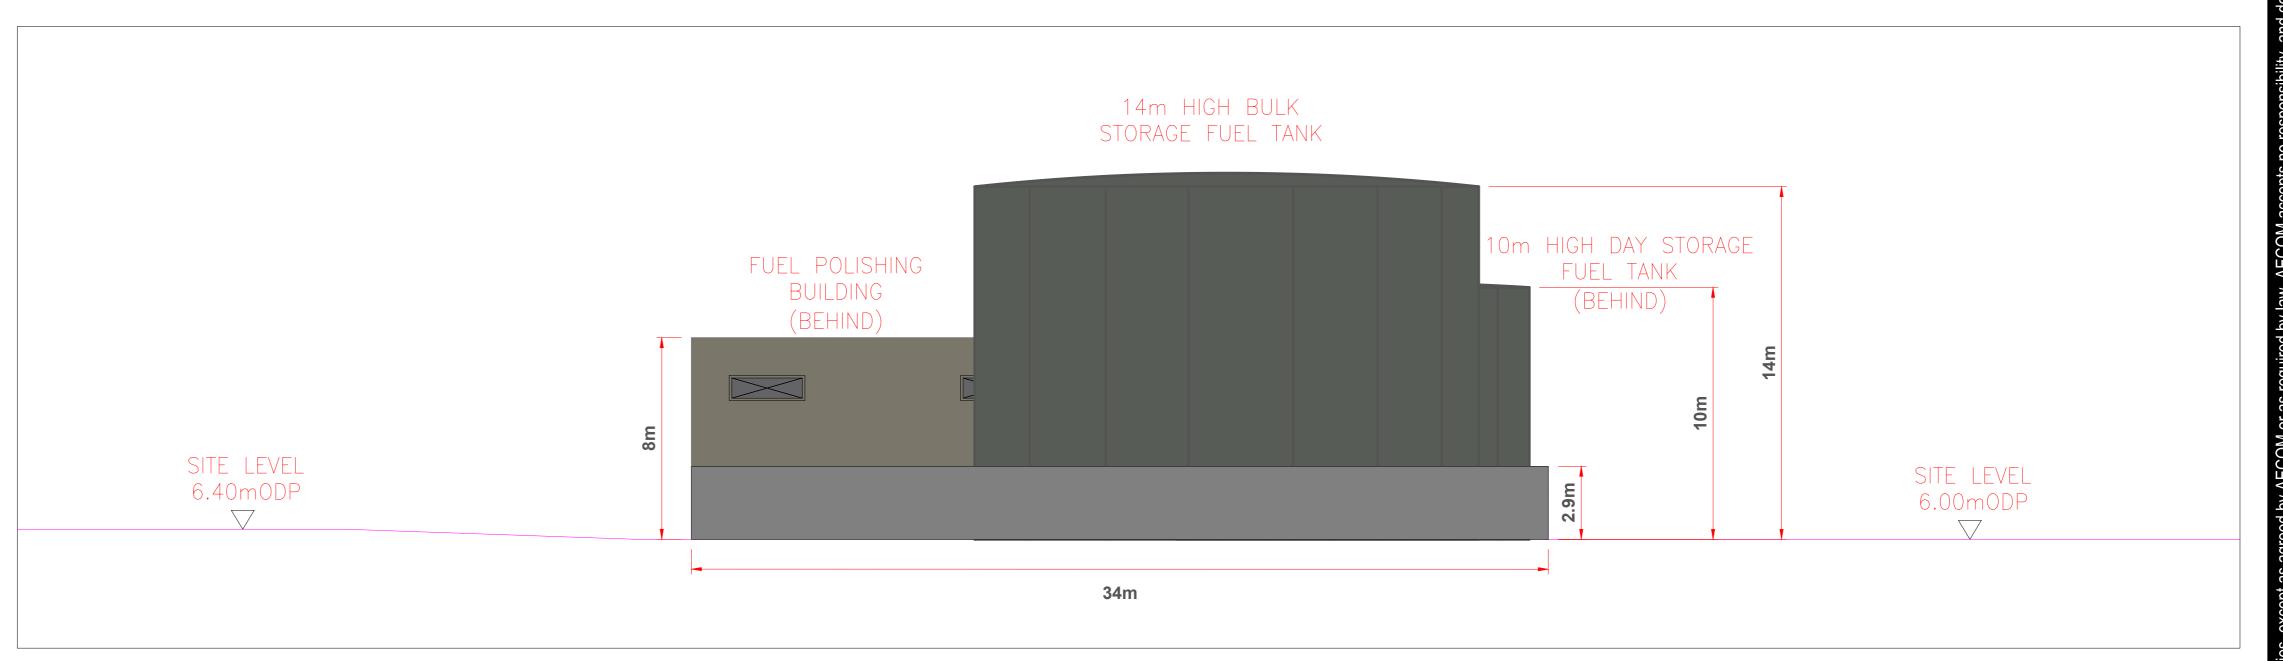

C-C SOUTH EAST ELEVATION

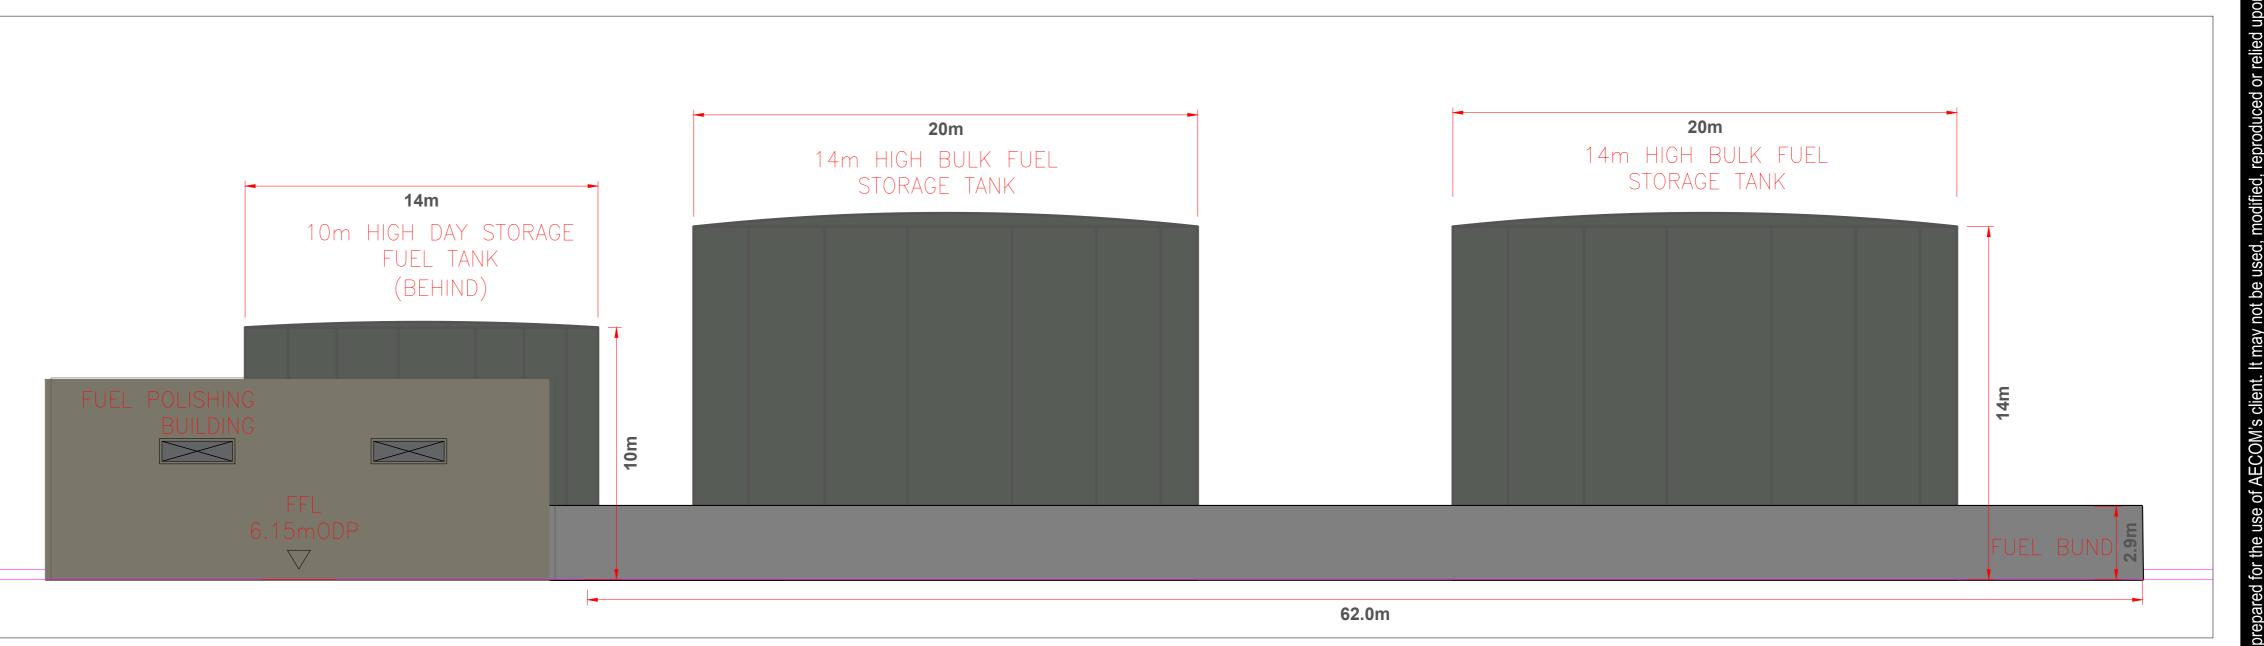

D-D SOUTH WEST ELEVATION



PROJECT

TARBERT NEXT
GENERATION POWER
STATION

CLIENT

SSE GENERATION IRELAND LTD

CONSULTANT

AECOM 2ND FLOOR, 177 BOTHWELL STREET GLASGOW G2 7ER +44 (0) 141 202 0500 www.AECOM.com

NOTES

- PROPOSED ELEVATIONS ARE RELATIVE TO ORDNANCE DATUM POOLBEG
- 2. TO BE PRINTED AT A0
- 3. REFER TO PROPOSED SITE ELEVATIONS FOR CONTIGUOUS DETAIL
- 4. FLOOD WALL OMITTED FOR CLARITY

DRAWN BY

CONOR COONEY

ISSUE/REVISION

| client. It may not b | | | |
|----------------------|-----|------------|--------------|
| | | | |
| | Α | 22/11/2023 | FOR PLANNING |
| | I/R | DATE | DESCRIPTION |
| လ | | | |

PROJECT NUMBER


60695232


SHEET TITLE

Fuel Tanks & Fuel Polishing & Transfer System - Plan & Elevations Sheet 1 of 2


SHEET NUMBER


60695232-TBT-DR-015

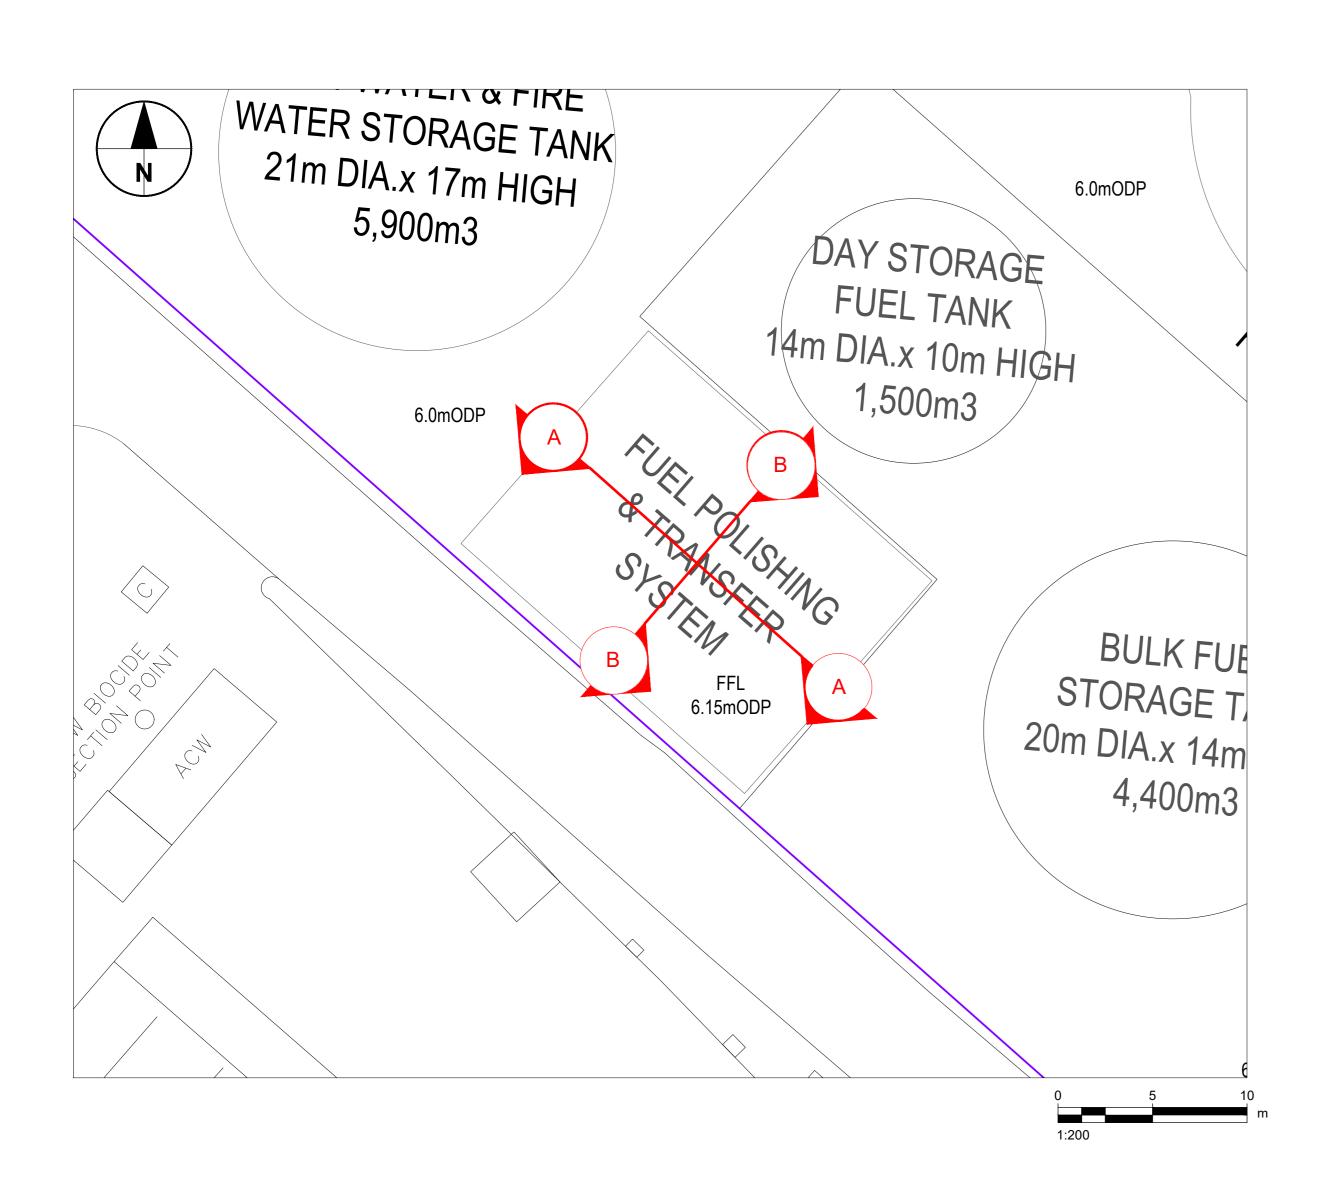

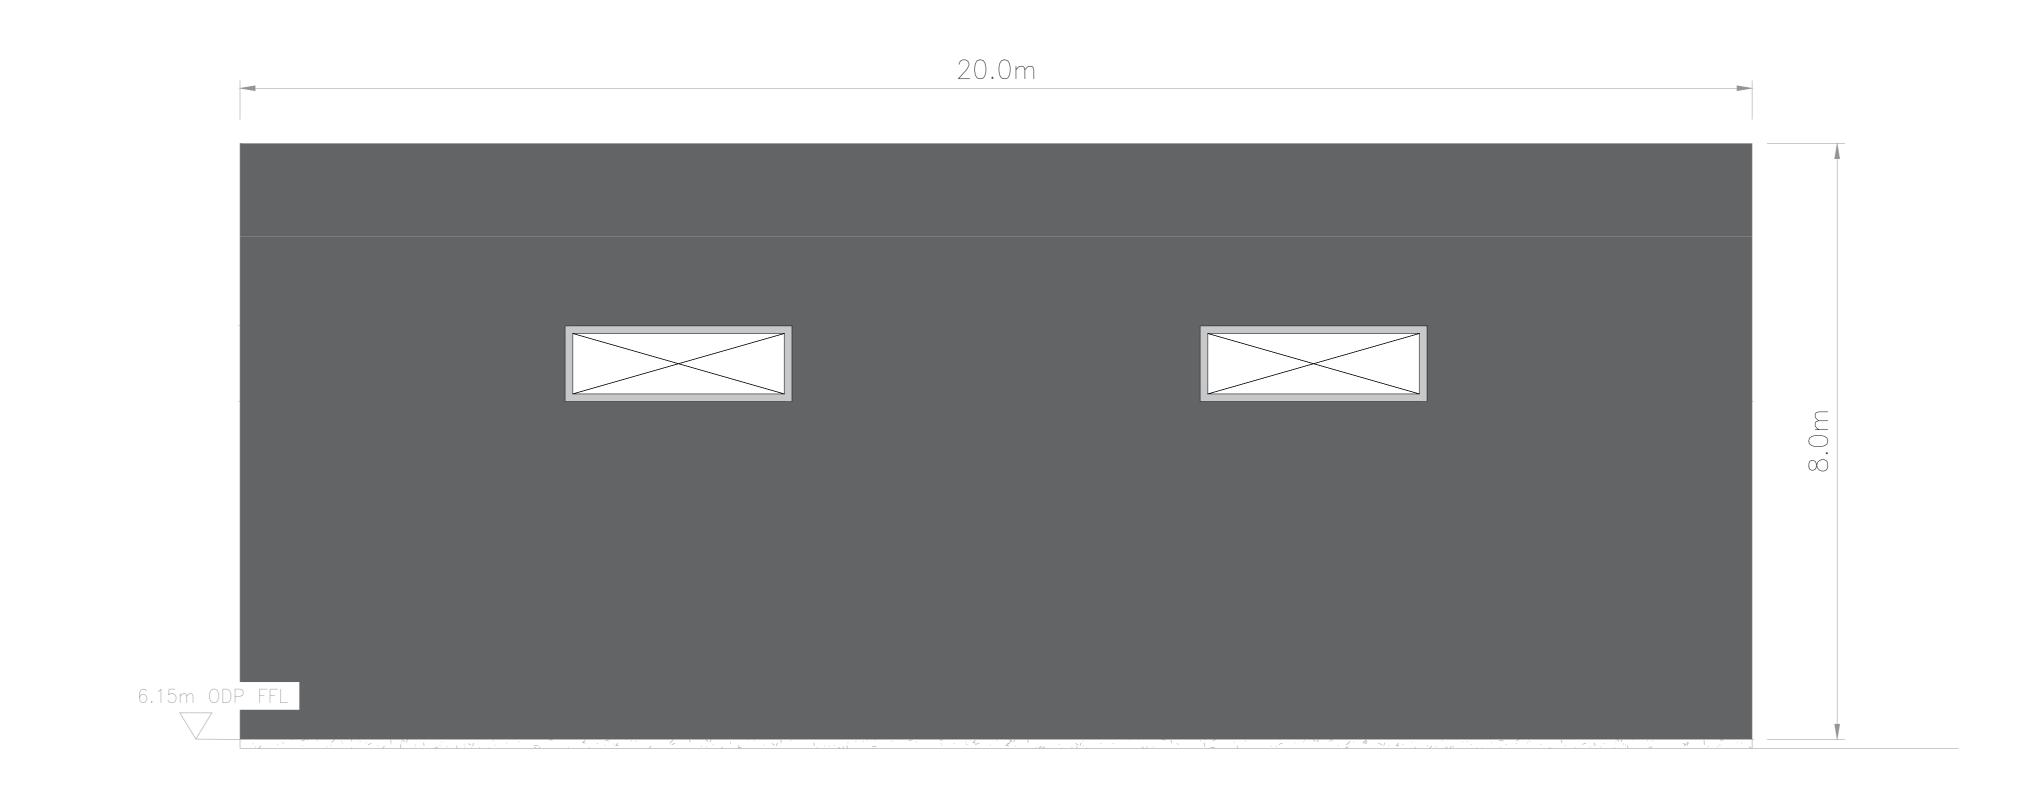


A-A NORTH EAST SECTION

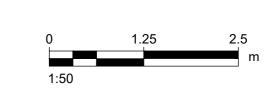

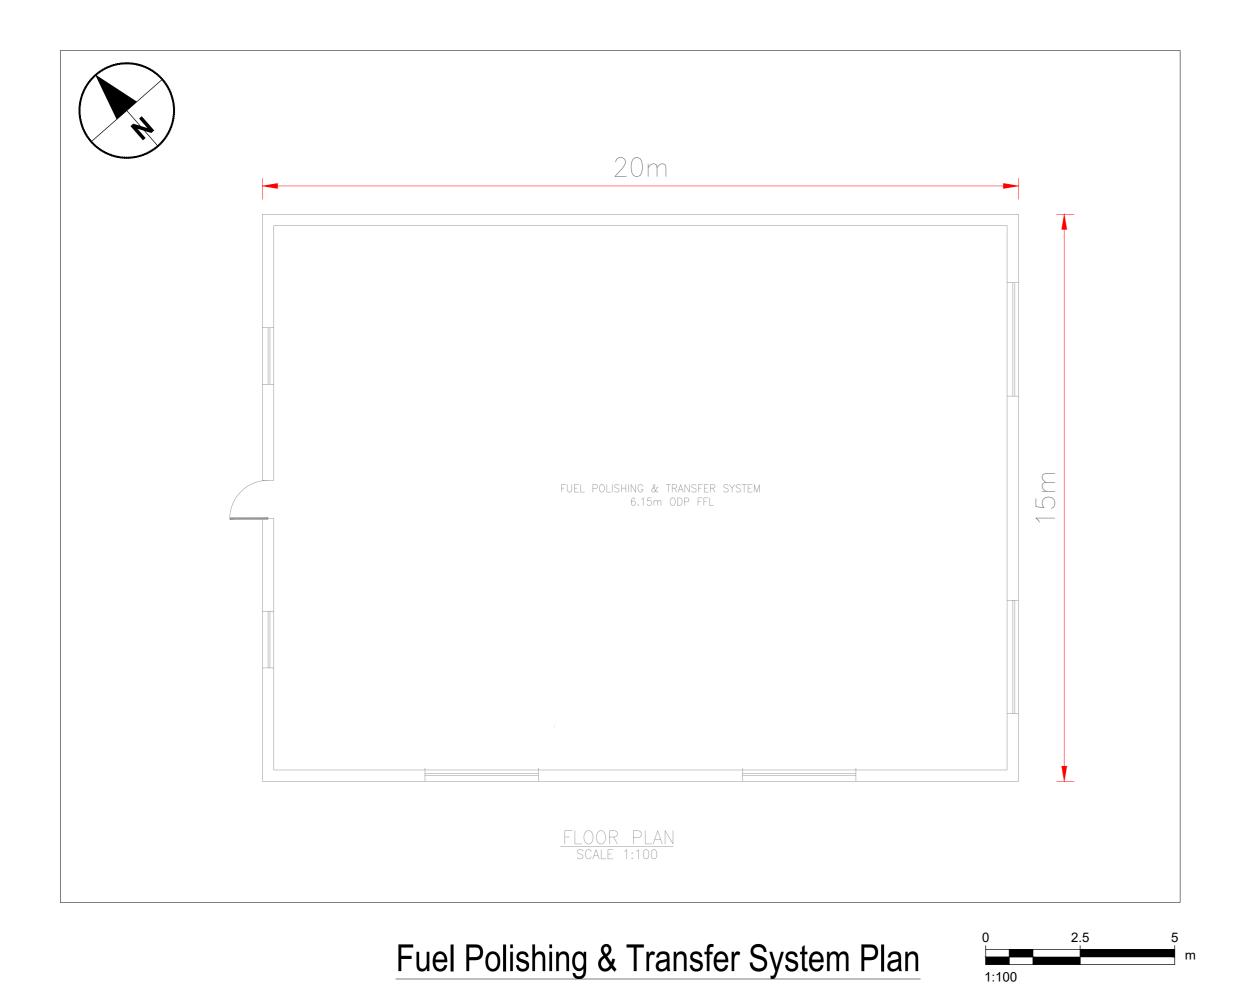



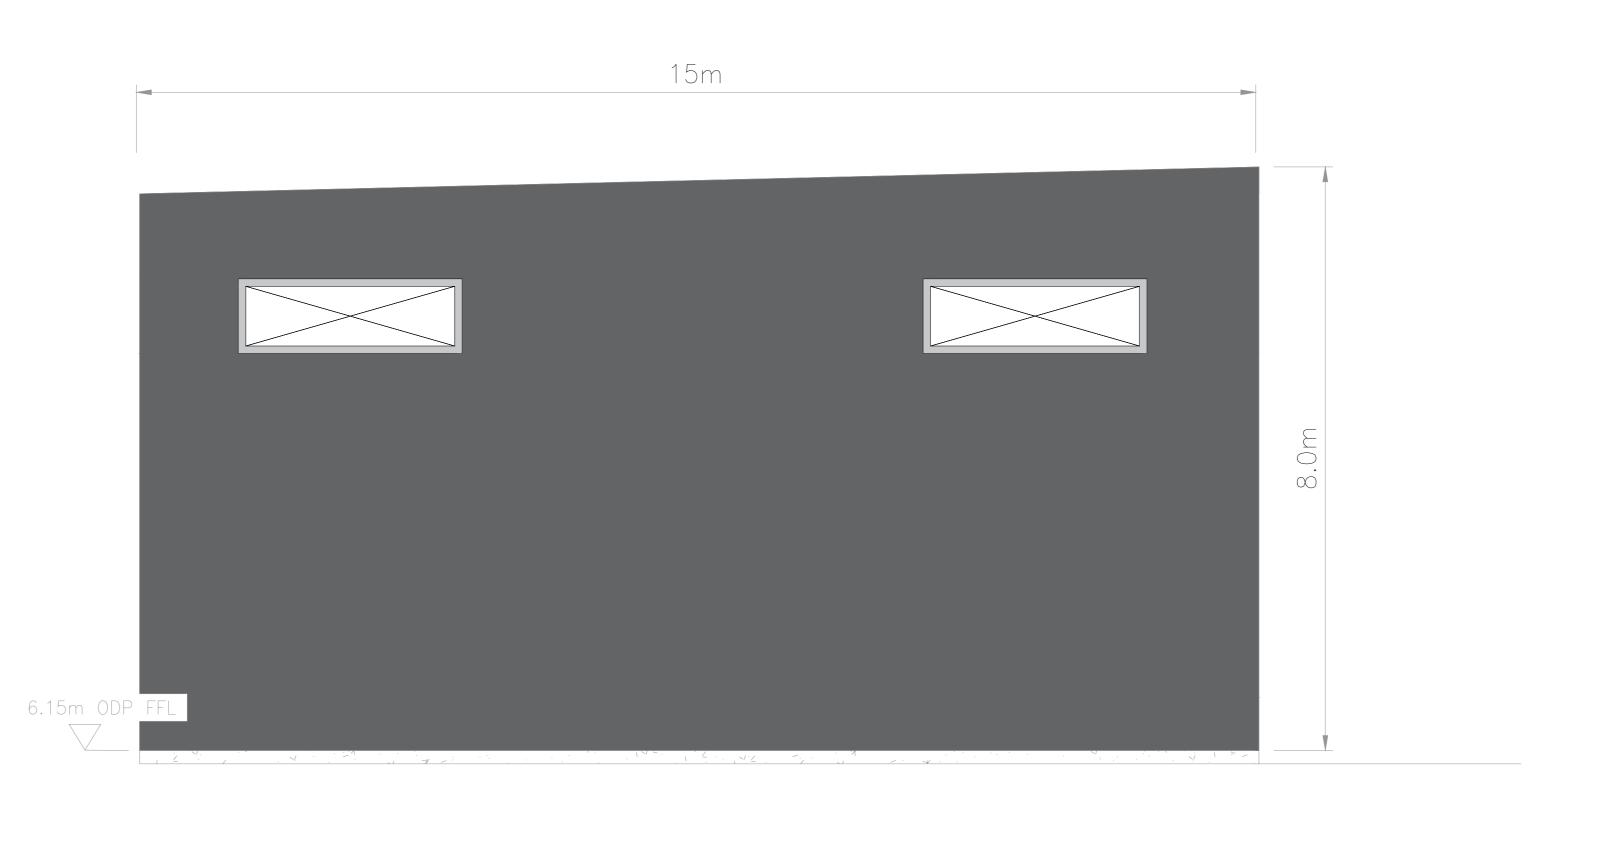

AECOM

PROJECT

TARBERT NEXT
GENERATION POWER
STATION

CLIENT

SSE GENERATION IRELAND LTD

CONSULTANT

AECOM 2ND FLOOR, 177 BOTHWELL STREET GLASGOW G2 7ER +44 (0) 141 202 0500 www.AECOM.com

NO.

- 1. PROPOSED ELEVATIONS ARE RELATIVE TO ORDNANCE DATUM POOLBEG
 - 2. TO BE PRINTED AT A0
 - 3. INTERNAL BUILDING LAYOUT WILL BE DEFINED AT DETAILED DESIGN STAGE

2.5 5 m

CONOR COONEY

ISSUE/REVISION

| a) | | | |
|------------|-----|------------|--------------|
| þe | | | |
| not | | | |
| It may not | | | |
| | Α | 22/11/2023 | FOR PLANNING |
| client. | I/R | DATE | DESCRIPTION |

PROJECT NUMBER

60695232

SHEET TITLE

Fuel Tanks & Fuel Polishing & Transfer System - Plan & Sections Sheet 2 of 2

SHEET NUMBER

60695232-TBT-DR-015